## **Perimeter Security Solutions**

## **IFI-12 Mini Louver Fence**

## **Security Fence**

## INDEX OF DRAWINGS

SHEET NO.	SHEET TITLE
1	TITLE SHEET AND GENERAL NOTES
2	EXTERIOR ELEVATION
3	TYPICAL DETAILS
4	GATE 1 FRAME
5	GATE 2 FRAME
	GATE 1 DETAILS
7	TYPICAL DETAILS
8	GATE OPERATOR DETAILS

## **GENERAL NOTES:**

- THE CONTRACTOR SHALL VERIFY EXISTING CONDITIONS, DIMENSIONS, AND ELEVATIONS IN THE FIELD PRIOR TO FABRICATION AND INSTALLATION OF ANY MATERIALS.
- 2. SECURITY SYSTEM CONDUITS AND CABLES SHALL NOT EXCEED 50 PLF.

## **MATERIAL NOTES:**

- ALL MATERIALS USED ON THE PROJECT SHALL BE AS SPECIFIED. SUBSTITUTIONS SHALL NOT BE PERMITTED WITHOUT APPROVAL FROM COLLINS ENGINEERS, INC.
- 2. POSTS AND RAILS SHALL BE GRADE 50 PIPES (Fy=30 KSI).
- 3. ALL WELDING SHALL USE E70XX ELECTRODES.
- MISCELLANEOUS STEEL (TENSION BARS, TENSION BANDS, BRACE BANDS, BOULEVARD CLAMPS, AND BOLTS) SHALL BE MINIMUM GRADE 30 (Fy=30 KSI).
- 5. GATE HINGES SHALL BE HEAVY DUTY RATED FOR MIN. 3'X7' GATE DIMENSION.
- CONCRETE ENCASEMENT SHALL HAVE MINIMUM COMPRESSIVE STRENGTH (1°c) OF 3000 PSI AT 14 DAYS.

#### Notes


- 1. Design for a 115-mph wind load.
- 2. Category C ASCE 7-10
- 3. Rapid Deployed "Easy Install"
- 4. "No Brackets"
- 5. Made In America
- 6. Patented



IFI-12 Mini Louver Barrier®

NOT TO SCALE



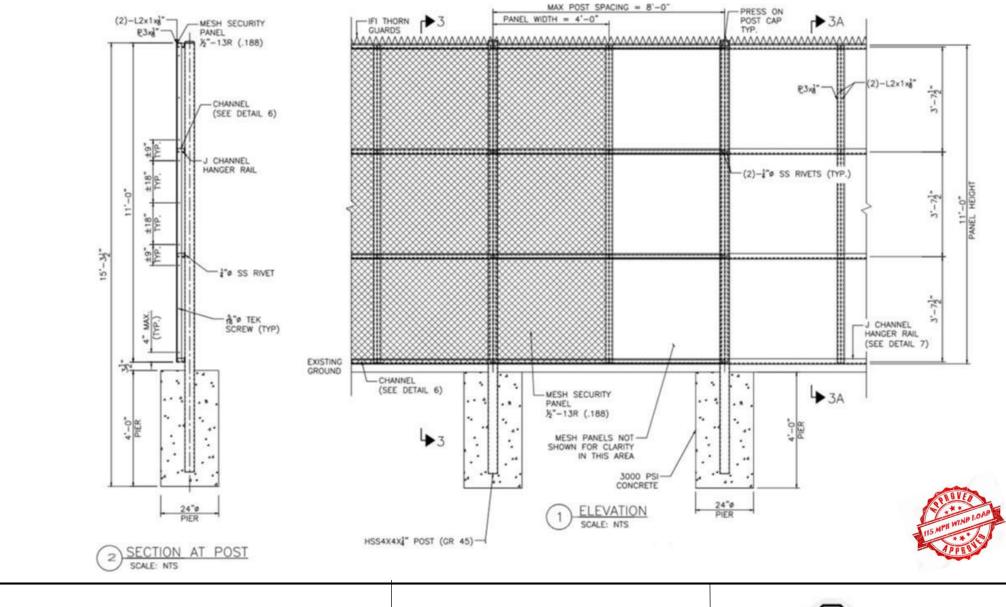

- Design for a 115-mph wind load.
- Category C ASCE 7-10
- Rapid Deployed "Easy Install"
- "No Brackets"
- Made In America
  - Patented




IFI-12 Mini Louver Barrier®

NOT TO SCALE



www.perimetersecuritysolutions.com

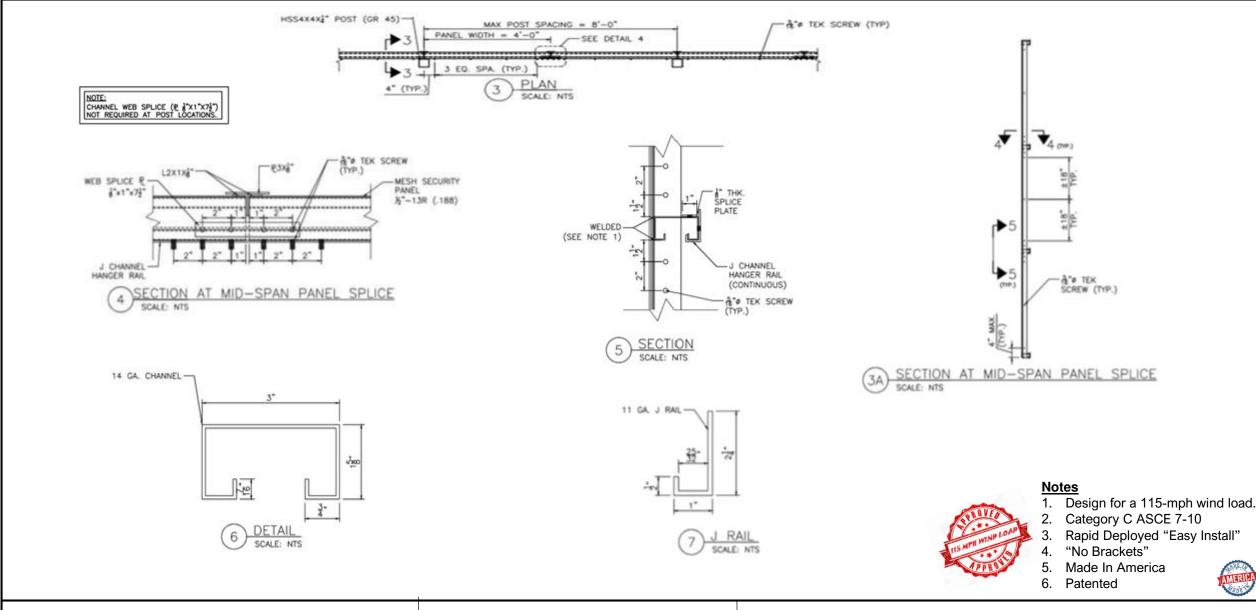



IFI-12 Mini Louver Barrier®

NOT TO SCALE



1300 S Kilbourn Ave Chicago IL 60623 www.perimetersecuritysolutions.com

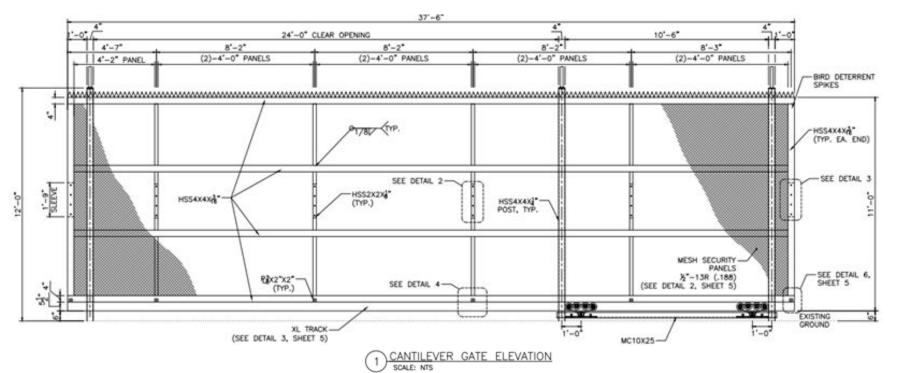

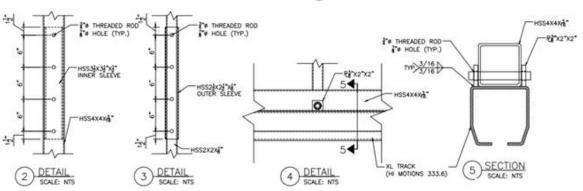

#### Note

- 1. Design for a 115-mph wind load.
- 2. Category C ASCE 7-10
- 3. Rapid Deployed "Easy Install"
- 4. "No Brackets"
- 5. Made In America
- . Patented





Astro-Glide Gate®


NOT TO SCALE




www.perimetersecuritysolutions.com

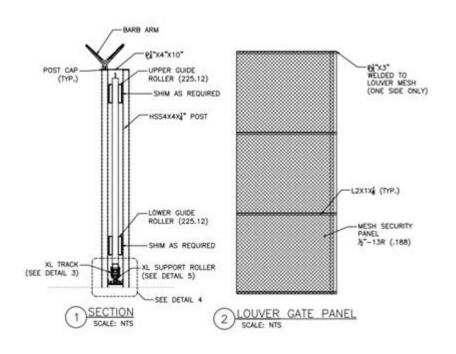

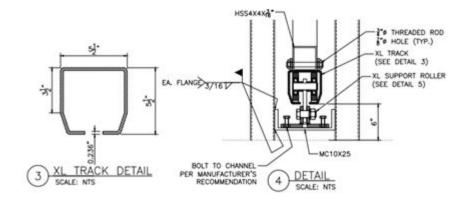

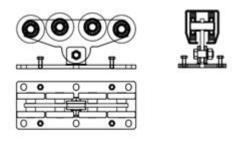

5 SUPPORT ROLLER DETAILS (HI MOTIONS 301.8XL)

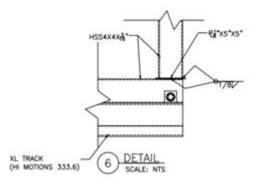

## Note:


- 1. Design for a 115-mph wind load.
- 2. Category C ASCE 7-10
- 3. Rapid Deployed "Easy Install"
- 4. "No Brackets"
- 5. Made In America
- 6. Patented







NOT TO SCALE



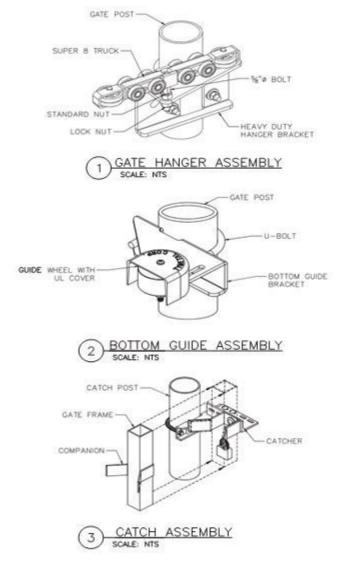

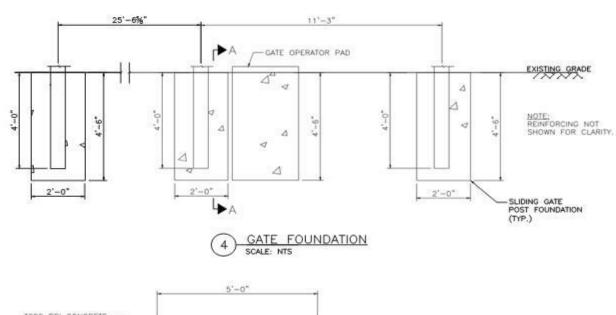

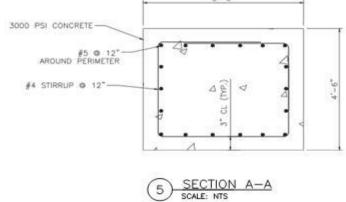

## Notes

- 1. Design for a 115-mph wind load.
- 2. Category C ASCE 7-10
- 3. Rapid Deployed "Easy Install"
- 4. "No Brackets"
- 5. Made In America
- 6. Patented



Astro-Glide Gate®


NOT TO SCALE




Perimeter Security Solutions.®

1300 S Kilbourn Ave Chicago IL 60623

www.perimetersecuritysolutions,com

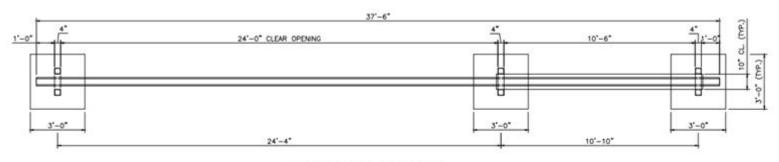

# 1 CANTILEVER GATE PLAN SCALE: NTS

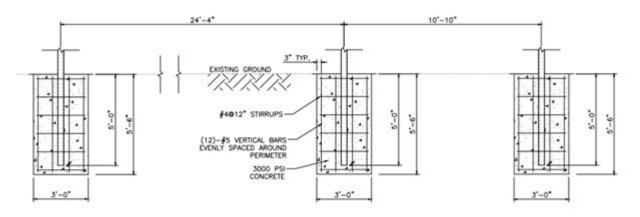

2 24' OPENING GATE FOUNDATION SCALE: NTS

## Notes

- 1. Design for a 115-mph wind load.
- 2. Category C ASCE 7-10
- 3. Rapid Deployed "Easy Install"
- 4. "No Brackets"
- 5. Made In America
- 6. Patented




Astro-Glide Gate®
Post layout

NOT TO SCALE




Perimeter Security Solutions.®

1300 S Kilbourn Ave Chicago IL 60623

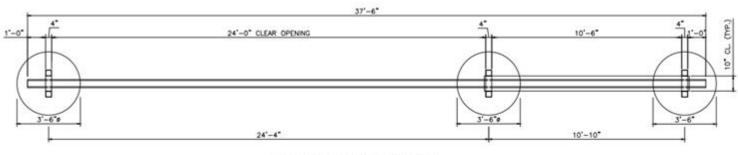

# 1 CANTILEVER GATE PLAN SCALE: NTS

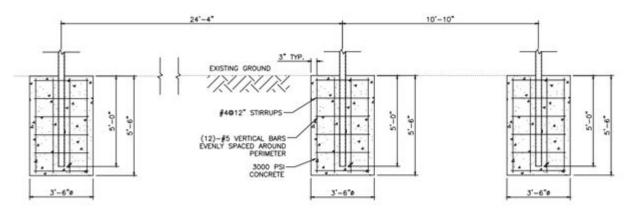

2 24' OPENING GATE FOUNDATION SCALE: NTS

## Note:


- 1. Design for a 115-mph wind load.
- 2. Category C ASCE 7-10
- 3. Rapid Deployed "Easy Install"
- 4. "No Brackets"
- 5. Made In America
- 6. Patented






NOT TO SCALE



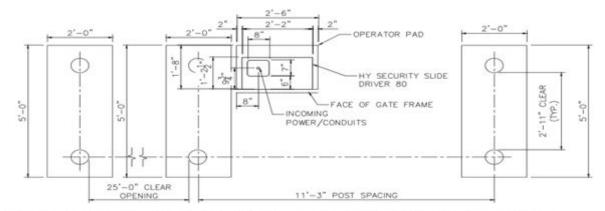

1) HY SECURITY SLIDE DRIVER 80 PLAN AND POST FOUNDATION LAYOUT SCALE: NTS

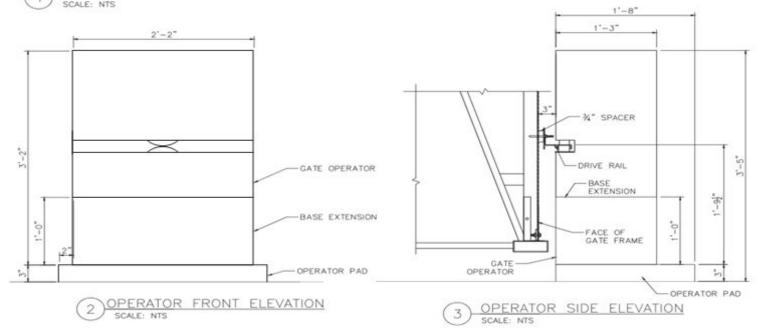



Astro-Glide Gate<sup>®</sup>

HD 80 Extreme Drive Operator

NOT TO SCALE



Perimeter Security Solutions.®

1300 S Kilbourn Ave Chicago IL 60623 www.perimetersecuritysolutions.com